



CITY OF BRAWLEY STANDARD DETAILS

WATER

- B-1 NEW 1" WATER SERVICE
- B-1B NEW 2" WATER SERVICE
- B-2 THRUST BLOCK
- B-3 RESIDENTIAL FIRE HYDRANT DETAIL
- B-3B COMMERCIAL FIRE HYDRANT DETAIL
- B-4 BLOW OFF
- B-5 VALVE BOX COLLAR

SEWER

- C-6 NEW SEWER SERVICE
- C-6B NEW SEWER TAP AND SERVICE

STREET

- E-1 HALF STREET DETAIL
- E-2 LIGHT TRAFFIC ALLEY CROSS CONNECTION (2/8)

CURB & GUTTER

- F-2B CURB & GUTTER DETAIL

DRIVEWAY

- G-2 COMMERCIAL DRIVEWAY DETAIL
- G-3 RESIDENTIAL DRIVEWAY DETAIL
- G-4 SIDEWALK DETAIL
- G-6 ALLEY APPROACH

STREET LIGHTS AND TRAFFIC SIGNING

- H-1 STREET LIGHT DETAIL
- H-7 TRAFFIC REGULATORY SIGNING
- H-8 STREET NAME SIGN INSTALLATION
- H-9 STREET NAME SIGN

MISC. DETAILS

- I-1 TRASH ENCLOSURES DETAIL

CITY OF BRAWLEY PUBLIC WORKS 760-344-5800 FAX 760-344-5612

A copy of the proposed site plan shall be submitted as soon as one is available for review by the Public Works Department. Three copies shall be submitted.

The developer will have to hire either an "A" General Engineering contractor license or a "C" Plumber


Specialty contractor license to perform a sewer tap.

Specialty Contractor License to perform all sidewalk, driveway and approaches.

The Public Works Department require the contractor to contact the department at least 48 hours prior to any proposed construction work at (760) 344-5800.

If a citizen would like the Public Works Department to locate a water main or sewer main, the administrative assistant may make a work order for the streets and utilities department and it may be marked out within five working days.

The City may perform the connection to the water main as long as the fees for the connection are paid at City Hall. The address to City Hall is 400 Main Street.

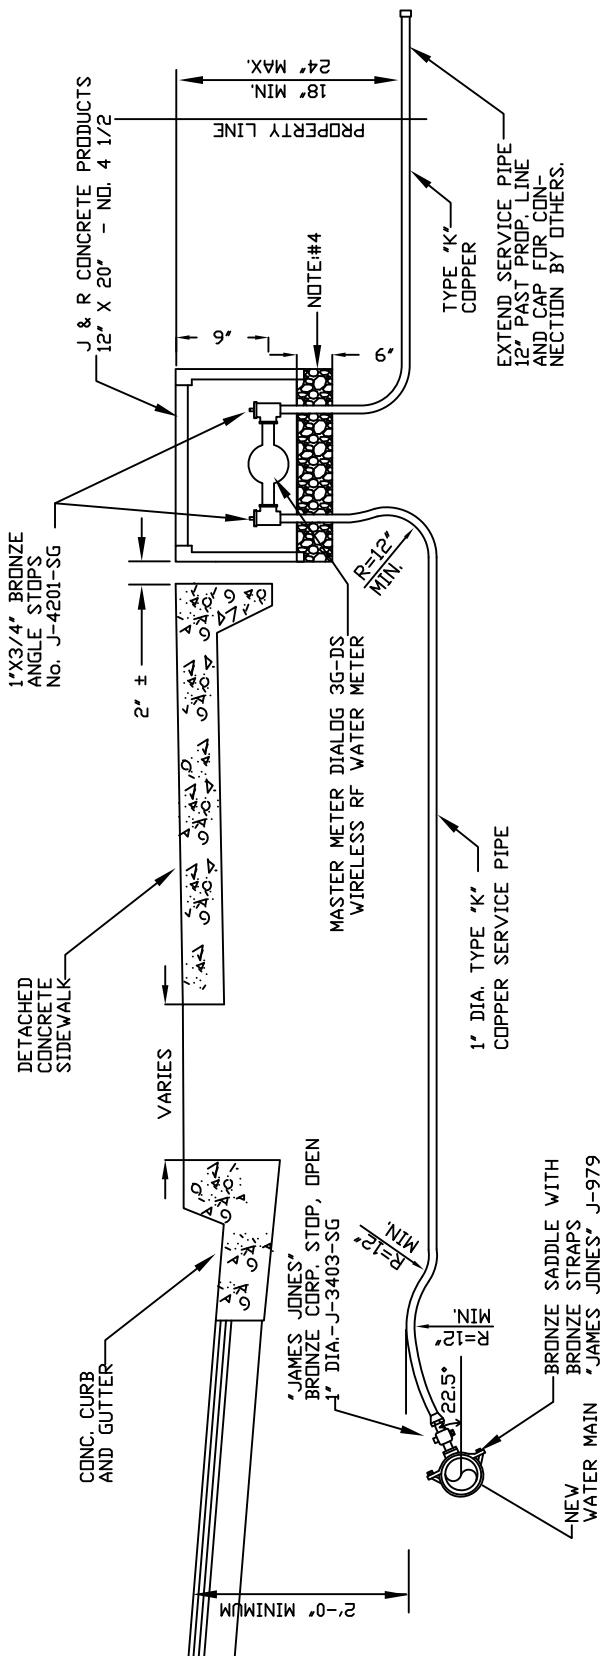

NOTES:

1. ALL TRENCH BACKFILL TO BE COMPACTED 90% AND RANDOMLY TESTED FOR DENSITY.
2. PROVIDE ONE SERVICE FOR EACH LOT.
3. STAMP CURB WITH "W" FOR LATERAL LOCATION.
4. INSTALL A MINIMUM OF 6' OF 3/4" ROCK BENEATH THE WATER METER BOX AND METER.



CITY OF BRAWLEY
ENGINEERING DEPT.
180 S. WESTERN AVE.
BRAWLEY, CA 92227
(760) 344-5800

APPROVED BY CITY ENGINEER:

STANDARD DETAILS

SCALE:

NTS

NEW 1" WATER SERVICE

B-1


BRAWLEY, CALIFORNIA

DATE: 12/6/06

BY: A.C.

OWNER: CITY OF BRAWLEY

JOB NO.

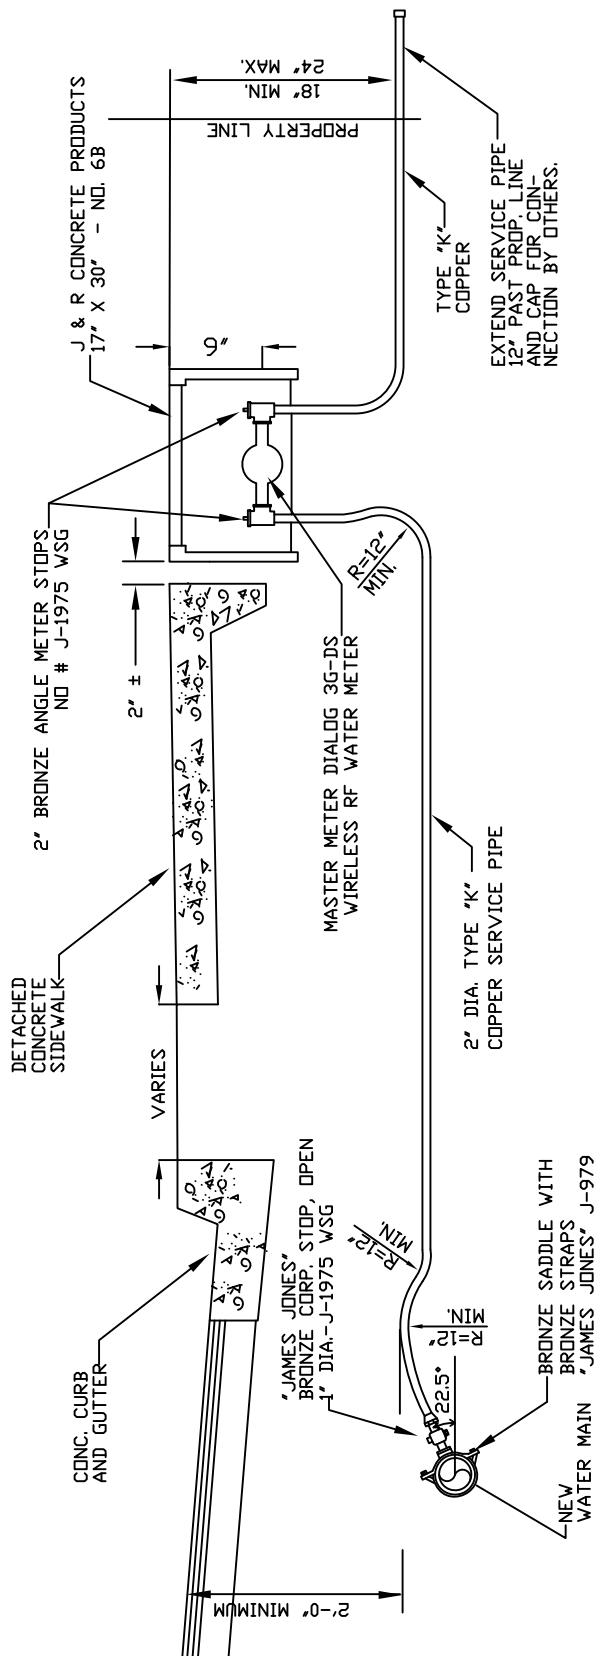

NOTES:

1. ALL TRENCH BACKFILL TO BE COMPACTED 90% AND RANDOMLY TESTED FOR DENSITY.
2. PROVIDE ONE SERVICE FOR EACH LOT.
3. STAMP CURB WITH "W" FOR LATERAL LOCATION.



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STANDARD DETAILS

SCALE:

NTS

NEW 2" WATER SERVICE


BRAWLEY, CALIFORNIA

DATE:
4/11/06

B-1B

OWNER: CITY OF BRAWLEY

BY:
A.C.
JOB NO.

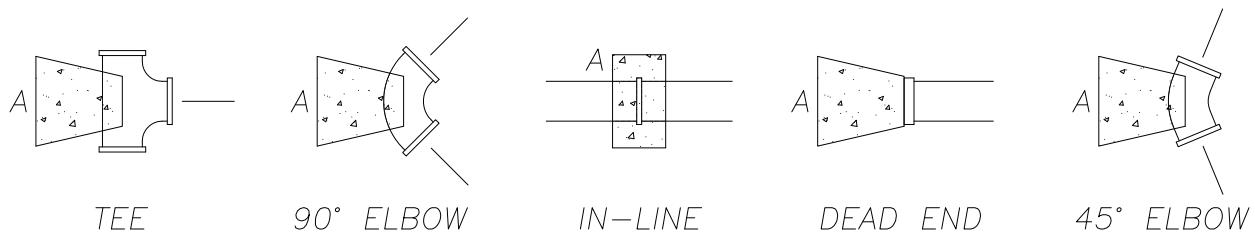

MINIMUM SQUARE FEET OF BEARING AREA REQUIRED FOR CONCRETE THRUST BLOCKS TESTED AT 100 PSI					
PIPE SIZE	TEE	90° ELBOW	IN-LINE	DEAD END	45° BEND
6" DIA.	3.7	5.3	3.7	3.7	2.9
8" DIA.	6.4	9.1	6.4	6.4	4.9
12" DIA.	13.7	19.4	13.7	13.7	10.5
14" DIA.	18.4	26.0	18.4	18.4	14.1
16" DIA.	23.8	26.00	23.8	23.8	18.3
18" DIA.	29.9	33.6	29.9	29.9	23.0

NOTES:


INDICATED AREAS SHALL BEAR ON FIRM, UNDISTURBED OR WELL-COMPACTED SOIL
 IN-LINE THRUST BLOCK SHALL INCLUDE EMBEDDED JOINT RESTRAINT DEVICES
 ALL CONCRETE SHALL BE NO LESS THAN 2000 P.S.I. AT 7 DAYS
 PROJECT TEST PRESSURES SHALL BE NO LESS THAN 125 P.S.I.

TYPICAL CONCRETE THRUST BLOCK DETAILS



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 BRAWLEY, CA 92227
 (760) 344-5800

CITY OF BRAWLEY ENGINEERING DEPT. 180 S. WESTERN AVE. BRAWLEY, CA 92227 (760) 344-5800	STANDARD DETAILS	SCALE: NTS	B-2
	THRUST BLOCK		
	BRAWLEY, CALIFORNIA	DATE 8/11/03	BY A.C.
	OWNER CITY OF BRAWLEY	JOB No.	

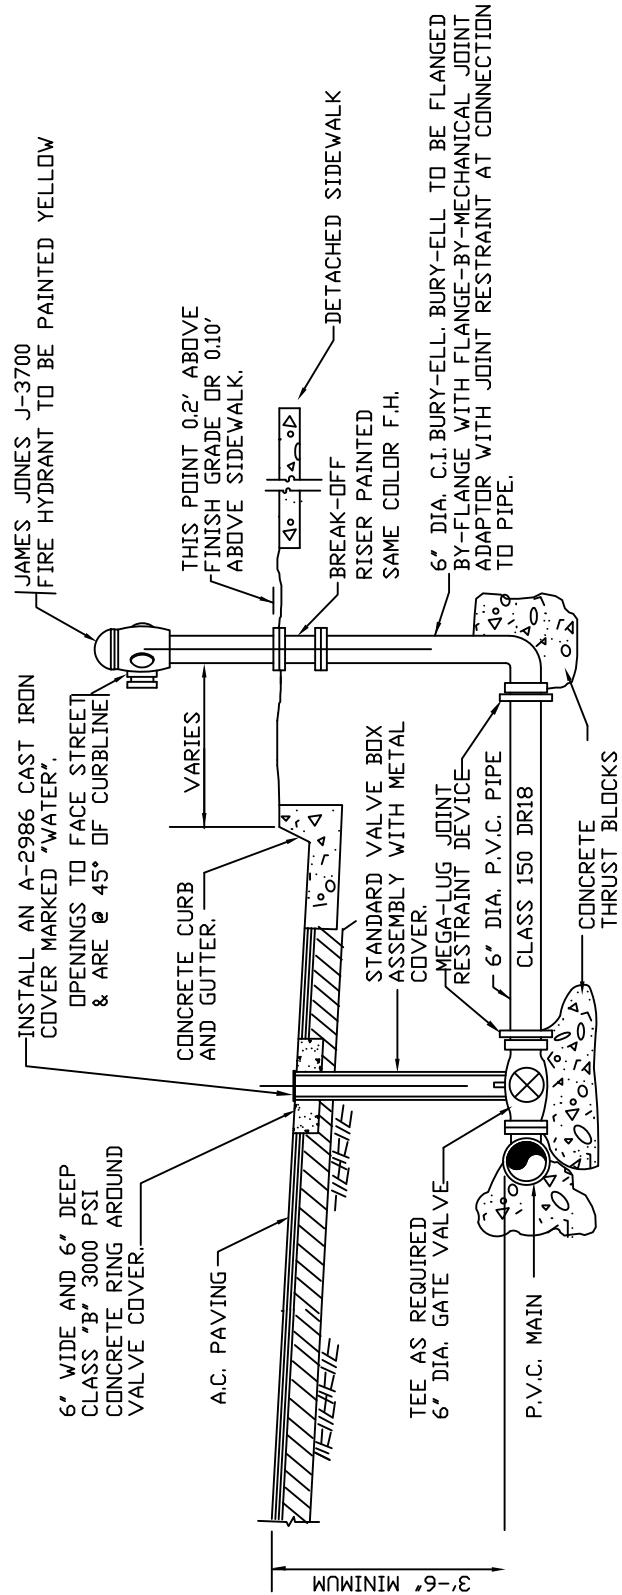

NOTES:

1. ALL FITTINGS TO BE CEMENT MORTAR LINED
2. NO VERTICAL OBJECTS WITHIN 6 FEET OF FIRE-HYDRANT
3. RESIDENTIAL 1-4" & 1-2 1/2"-JAMES JONES J-3700 FIRE HYDRANT
4. ALL TRENCHES SHALL BE BACKFILLED WITH SAND AND COMPACTED TO 95%
5. C-900 CLASS 150 P.V.C. DR18 PIPE FOR THE VERTICAL PIECE ON TOP OF THE VALVE.



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APPROVED BY CITY ENGINEER:

STANDARD DETAILS
RESIDENTIAL FIRE HYDRANT
DETAIL

BRAWLEY, CALIFORNIA


OWNER: CITY OF BRAWLEY

SCALE:
NTS

DATE: 8/12/05 BY: A.C.

JOB NO.

B-3

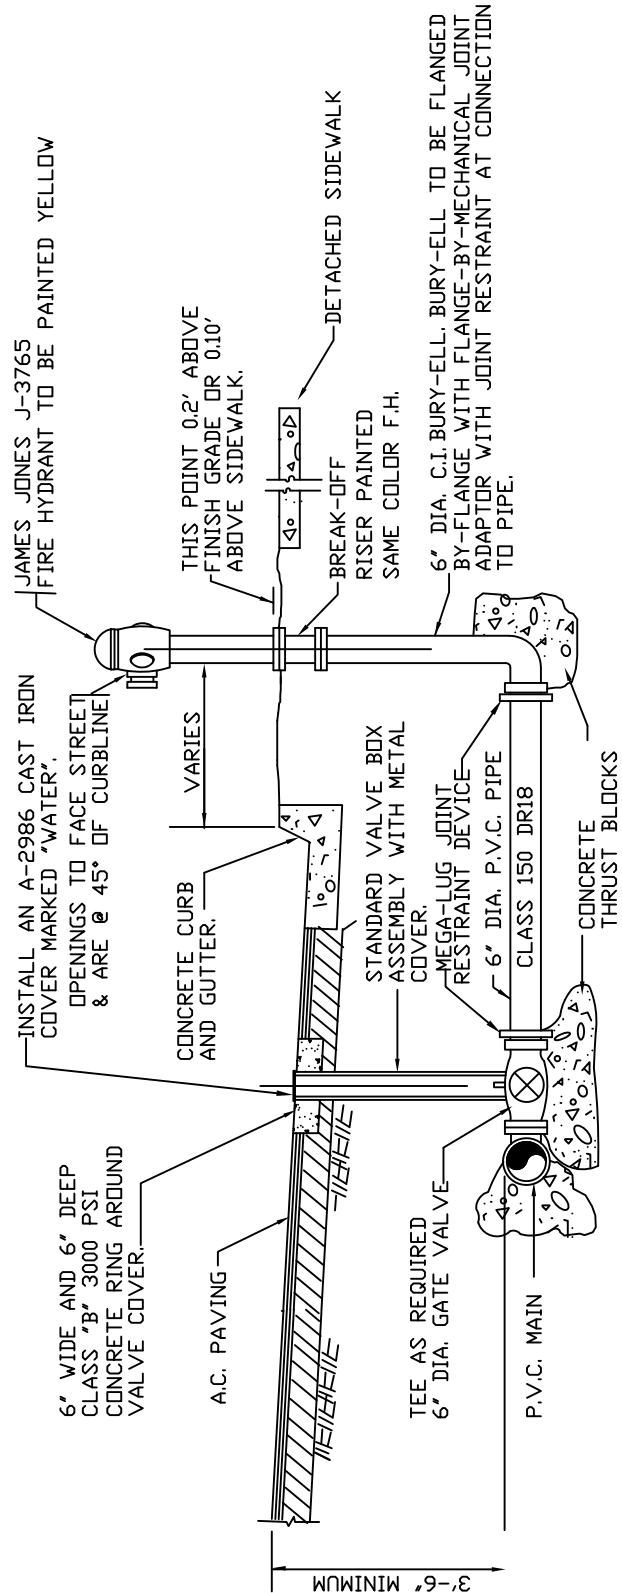

NOTES:

1. ALL FITTINGS TO BE CEMENT MORTAR LINED
2. NO VERTICAL OBJECTS WITHIN 6 FEET OF FIRE-HYDRANT
3. COMMERCIAL 1-4" & 2-2 1/2"-JAMES JONES J-3765 FIRE HYDRANT
4. ALL TRENCHES SHALL BE BACKFILLED WITH SAND AND COMPACTED TO 95%
5. C-900 CLASS 150 P.V.C. DR18 PIPE FOR THE VERTICAL PIECE ON TOP OF THE VALVE.



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APPROVED BY CITY ENGINEER:

STANDARD DETAILS

SCALE:

NTS


COMMERCIAL FIRE HYDRANT
DETAIL

B-3B


BRAWLEY, CALIFORNIA

DATE: 10/5/04 BY: A.C.
JOB NO.

OWNER: CITY OF BRAWLEY

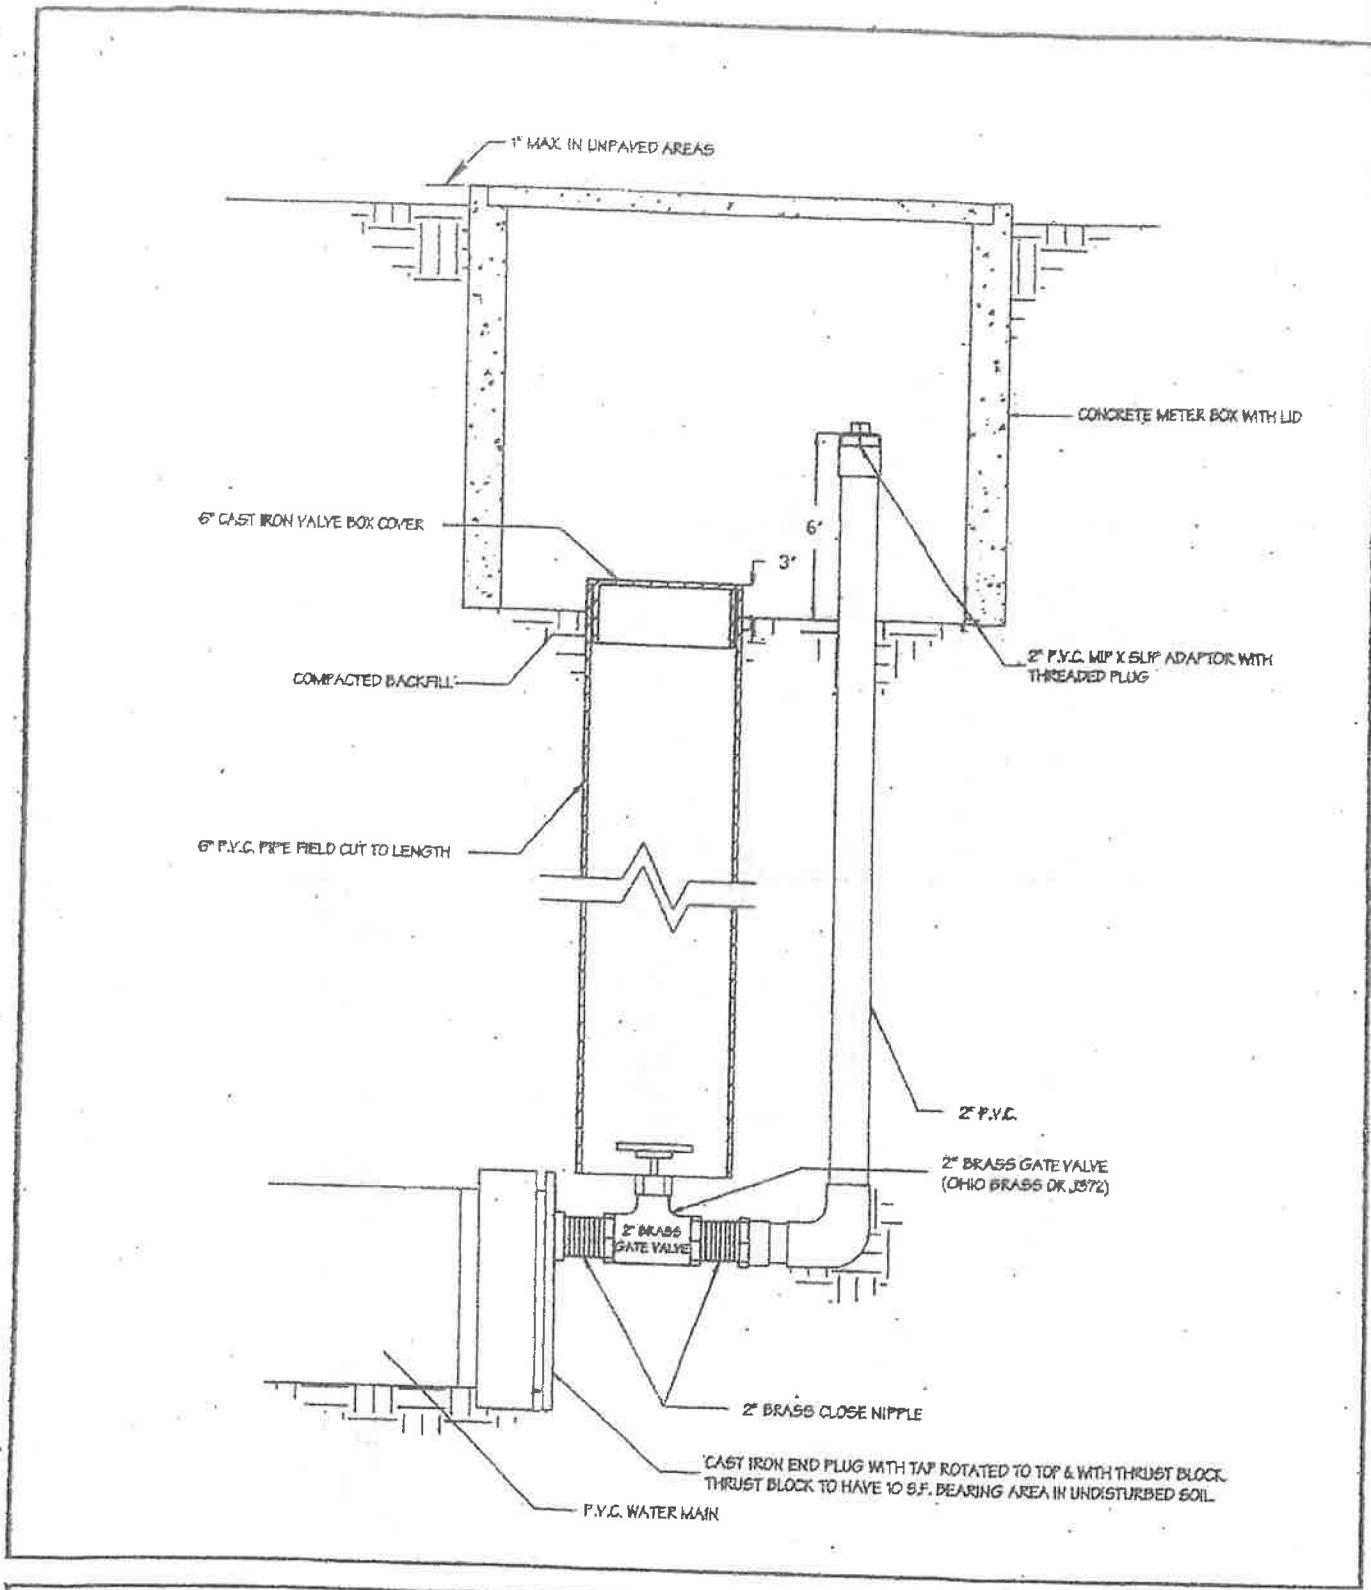

<p>CITY OF BRAWLEY ENGINEERING DEPT. 180 S. WESTERN AVE. BRAWLEY, CA 92227 (760) 344-5800</p>	STANDARD DETAILS		NTS B-4
	BLOW OFF		
OWNER	BRAWLEY, CALIFORNIA CITY OF BRAWLEY	DATE 8/19/03 JOB NO.	BY A.C.

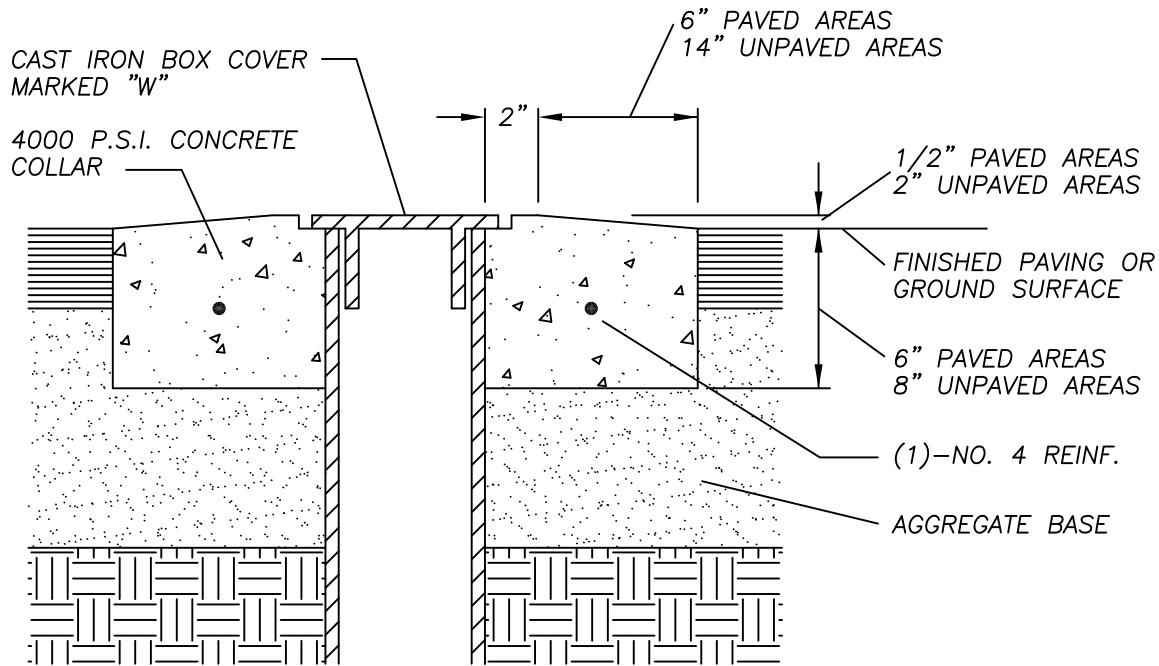


NOT TO SCALE

TYPICAL VALVE BOX COLLAR DETAIL



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STANDARD DETAILS		SCALE:	NTS
VALVE BOX COLLAR			B-5
BRAWLEY, CALIFORNIA		DATE 8/11/03	BY A.C.
OWNER CITY OF BRAWLEY		JOB No.	

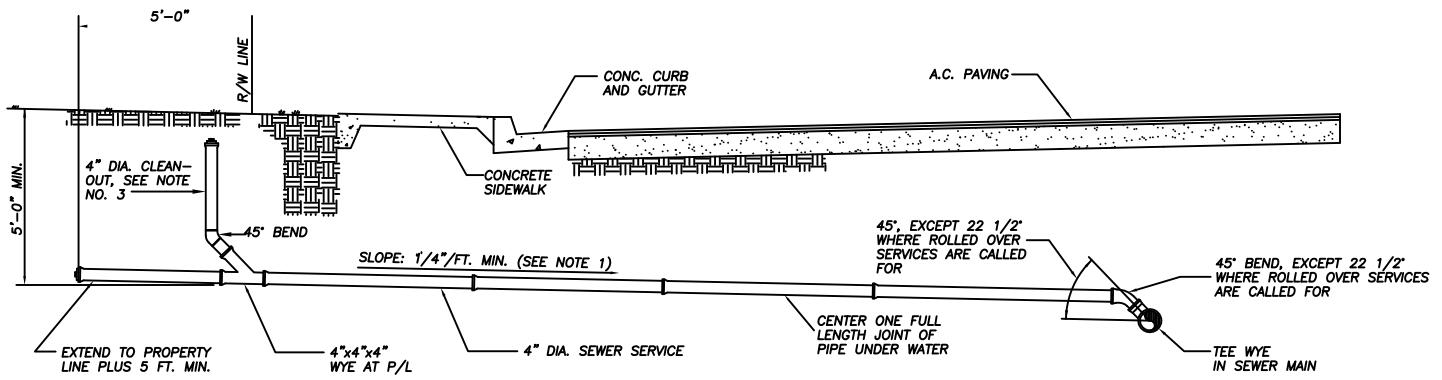

NOTES:

1. $\frac{1}{8}$ " / FT. ALLOWED TO MEET MINIMUM DEPTH AT PROPERTY LINE OR WATER LINE CLEARANCE REQUIREMENTS.
2. ALL TRENCH BACKFILL TO BE COMPACTED 90% MINIMUM AND RANDOMLY TESTED AT 1 TEST EVERY 3 SERVICES.
3. EXTEND 4" DIA. CLEAN-OUT WITH STOPPER TO WITHIN 12" OF GROUND SURFACE.



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STANDARD DETAIL

SCALE:

NTS

NEW SEWER SERVICE

C-6


BRAWLEY, CALIFORNIA

DATE
7/12/02

BY
A.C.

OWNER CITY OF BRAWLEY

JOB
No.

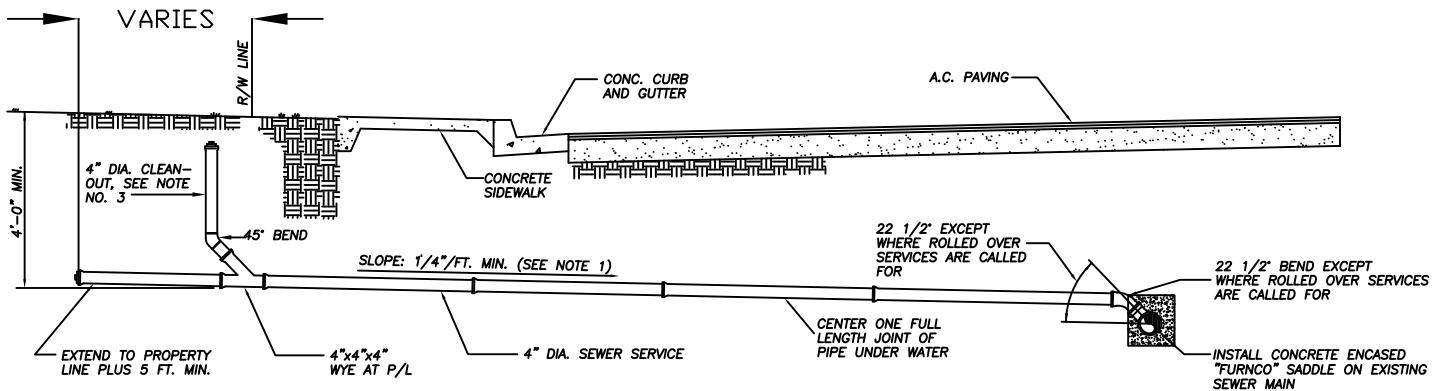

NOTES:

1. $\frac{1}{8}$ " / FT. ALLOWED TO MEET MINIMUM DEPTH AT PROPERTY LINE OR WATER LINE CLEARANCE REQUIREMENTS.
2. ALL TRENCH BACKFILL TO BE COMPACTED 90% MINIMUM AND RANDOMLY TESTED OR POUR 2-SACK SLURRY TO GRADE AND PATCH BACK TRENCH ZONE WITH "HOTMIX" ASPHALT CONCRETE TO MATCH EXISTING.
3. EXTEND 4" DIA. CLEAN-OUT WITH STOPPER TO WITHIN 12" OF GROUND SURFACE.




CITY OF BRAWLEY
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STANDARD DETAIL		NTS
NEW SEWER TAP AND SERVICE		C-6 B
BRAWLEY, CALIFORNIA	DATE 7/30/03	BY A.C.
OWNER CITY OF BRAWLEY	JOB No.	

TABLE OF HALF-STREET
WIDTH CHARACTERISTICS

	"A"	"B"	"C"
RESIDENTIAL	30'-0"	20'-0"	10'-0"
RESIDENTIAL / INDUSTRIAL	40'-0"	25'-0"	15'-0"
INDUSTRIAL	50'-0"	30'-0"	20'-0"

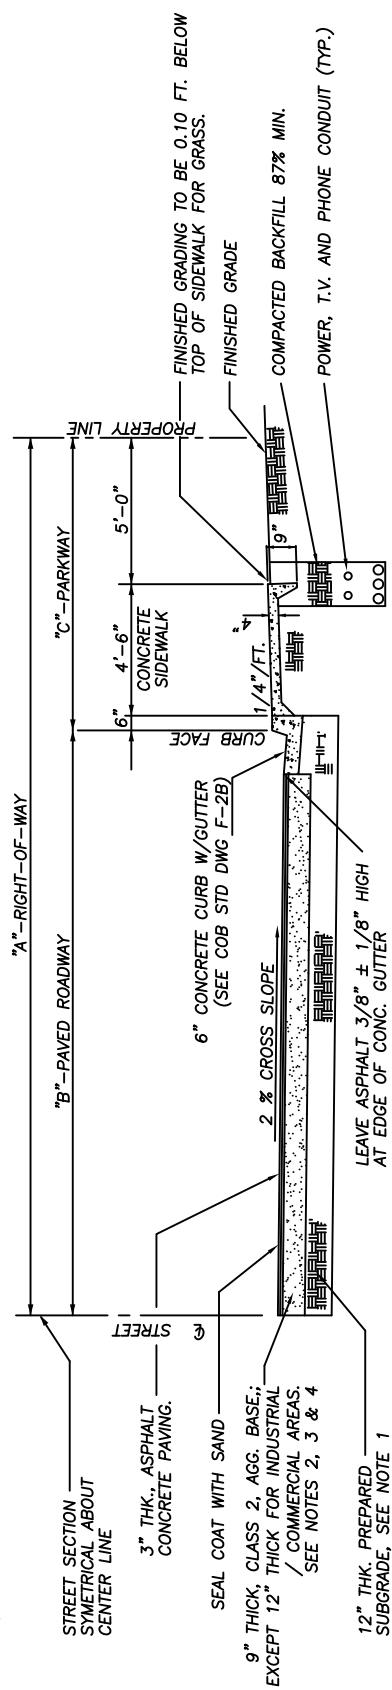

NOTE:

1. SUBGRADE COMPACTION TO 90% MIN. COMPACTION, AND COMPLY WITH 2003 GREENBOOK SEC. 301-1.2 PREPARATION INCLUDES SCARIFY AND RE-COMPACT.
2. CLASS 2 BASE COMPACTION TO 95% MIN. COMPACTION, AND COMPLY WITH 2003 GREEN BOOK SEC. 301-2.3
3. RESIDENTIAL AND LIGHT INDUSTRIAL 3" THICK ASPHALT CONCRETE PAVING, WITH 9" THICK OF CLASS 2 BASE.
4. INDUSTRIAL AND COMMERCIAL 3" THICK ASPHALT CONCRETE PAVING, WITH 12" THICK OF CLASS 2 BASE.

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APPROVED BY CITY ENGINEER:

STANDARD DETAILS

SCALE:
NTS

HALF STREET DETAIL



E-1

BRAWLEY, CALIFORNIA

DATE: 10/5/04 BY: A.C.

OWNER: CITY OF BRAWLEY


JOB NO.

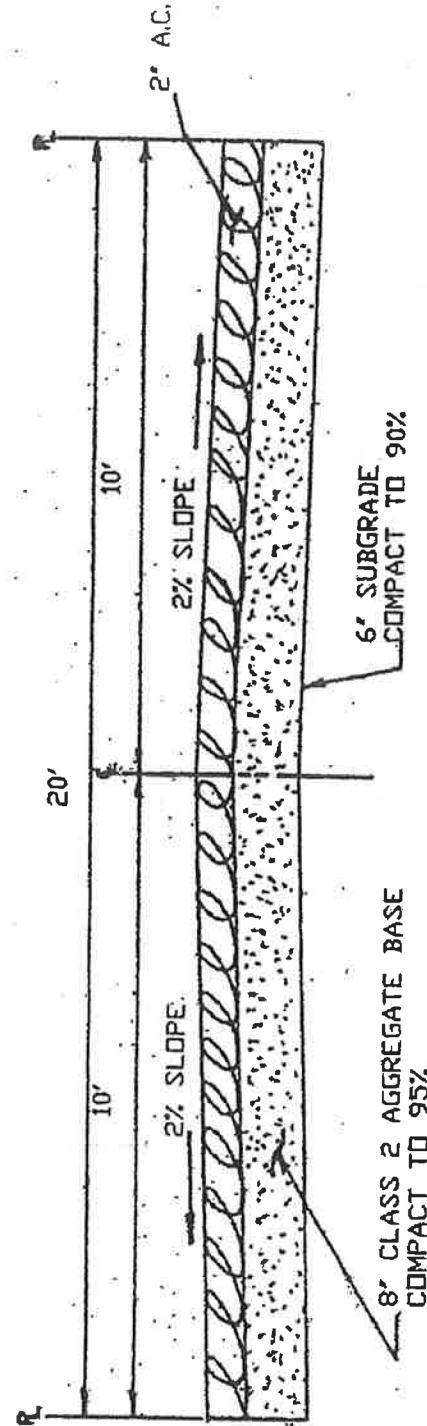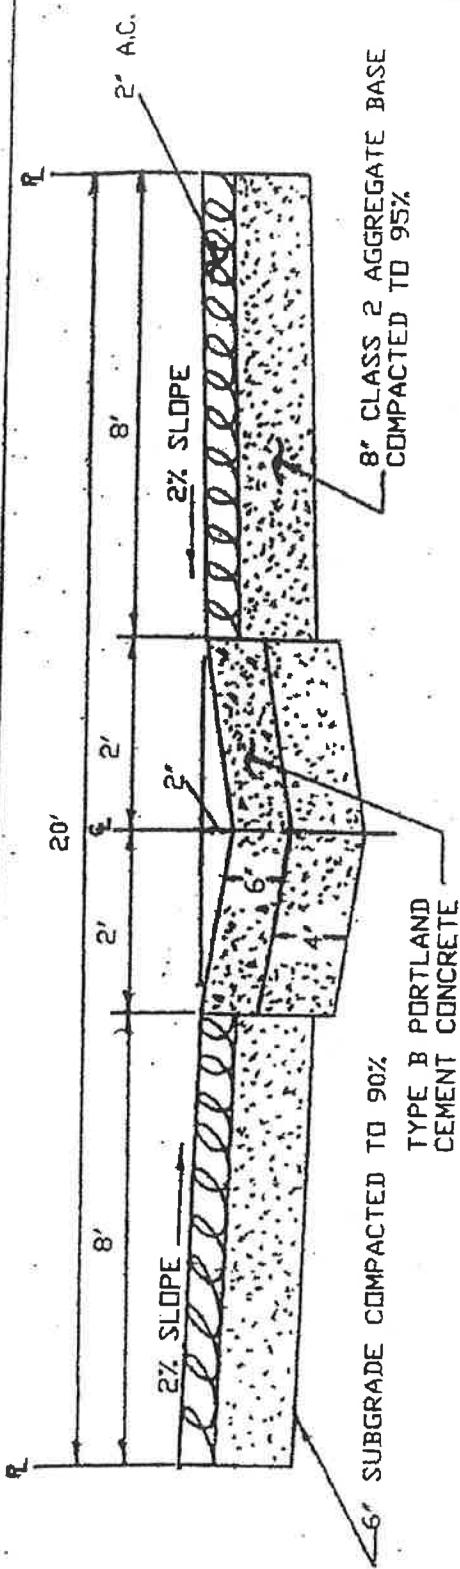

NOTE: 1) THESE CROSS SECTION MAY BE USED ONLY WITH THE APPROVAL OF THE CITY ENGINEER.

LIGHT TRAFFIC ALLEY CROSS SECTION (2/8)				
CITY OF BRAWLEY		STANDARD DETAIL		
DRAWN BY	A.C.	CHECKED BY	Y.A.T.	REVISED BY
DATE	11-19-2001	DATE	12-24-01	DATE

E-2

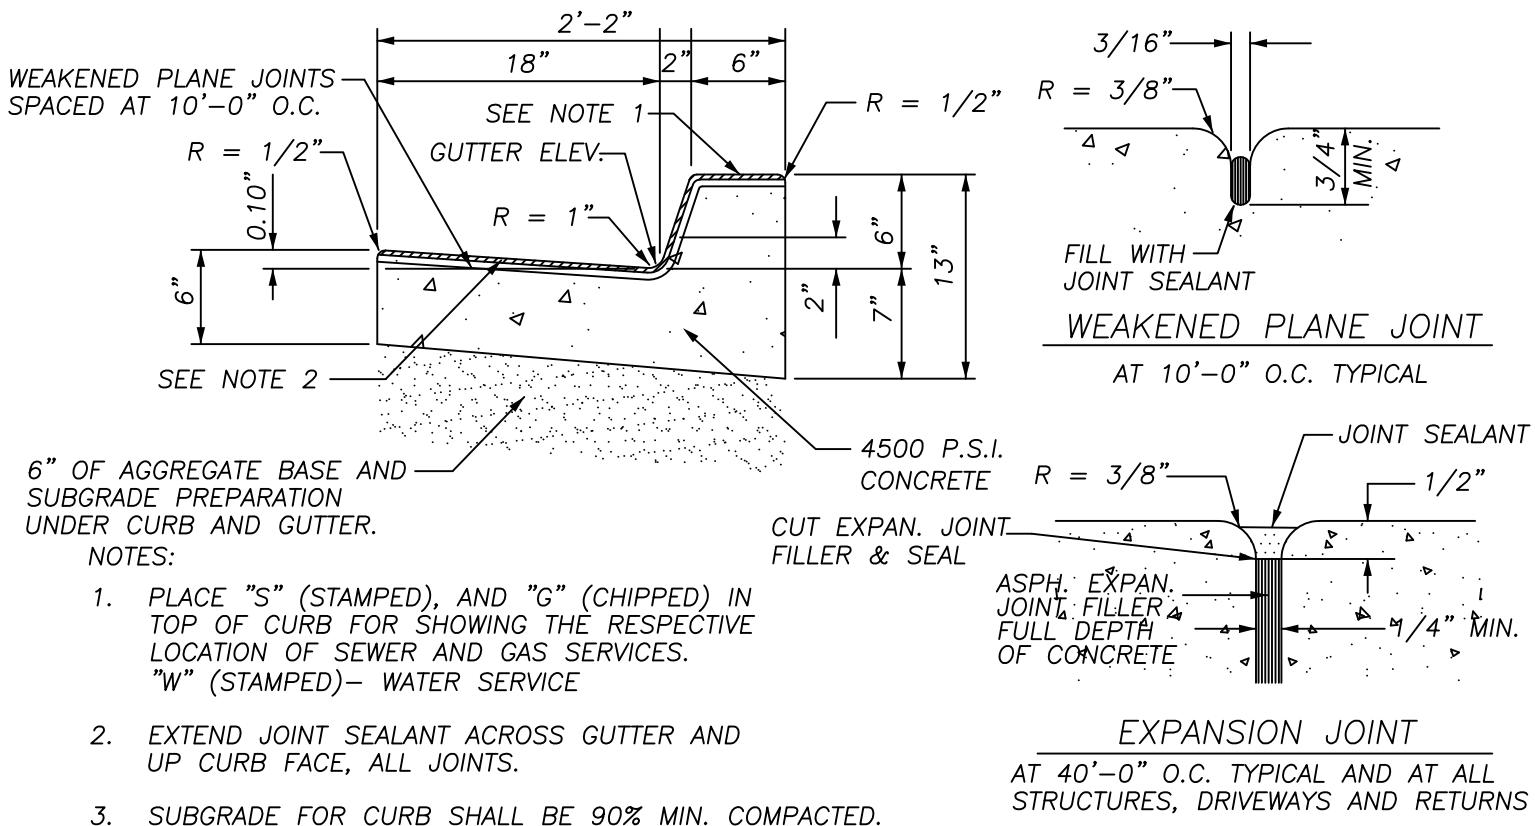

CITY OF BRAWLEY
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APPROVED BY CITY ENGINEER:

STANDARD DETAILS

SCALE:

NTS

F-2

B

CURB & GUTTER DETAIL

BRAWLEY, CALIFORNIA

DATE: 10/5/04 BY: A.C.


OWNER: CITY OF BRAWLEY

JOB NO.

**TJ = 3/4" MIN.
DEEP TOOLED
JOINT**

MAT OF STEEL
- #3 REBAR AT 18" O.C.
(SEE NOTE 3)


DETACHED SIDEWALK

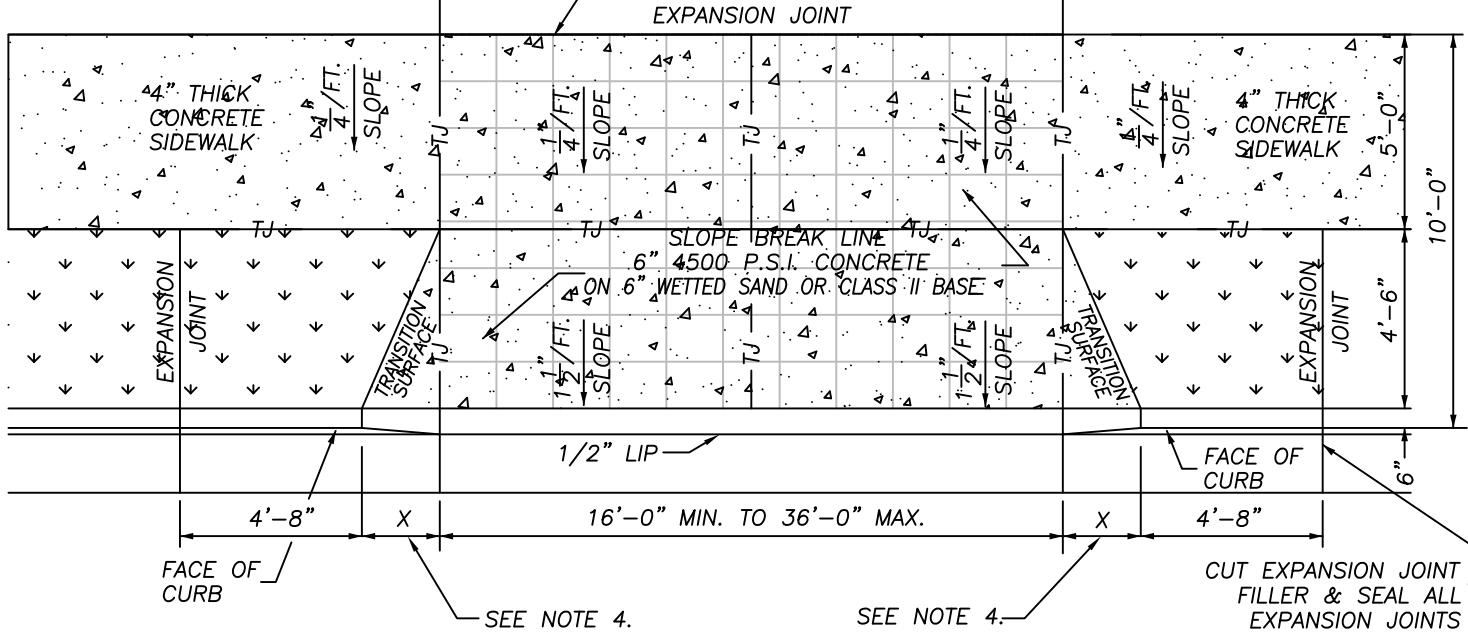

**TJ = 3/4" MIN.
DEEP TOOLED
JOINT**

MAT OF STEEL
#3 REBAR AT 18" O.C.
(SEE NOTE 3)
EXPANSION JOINT

ATTACHED SIDEWALK

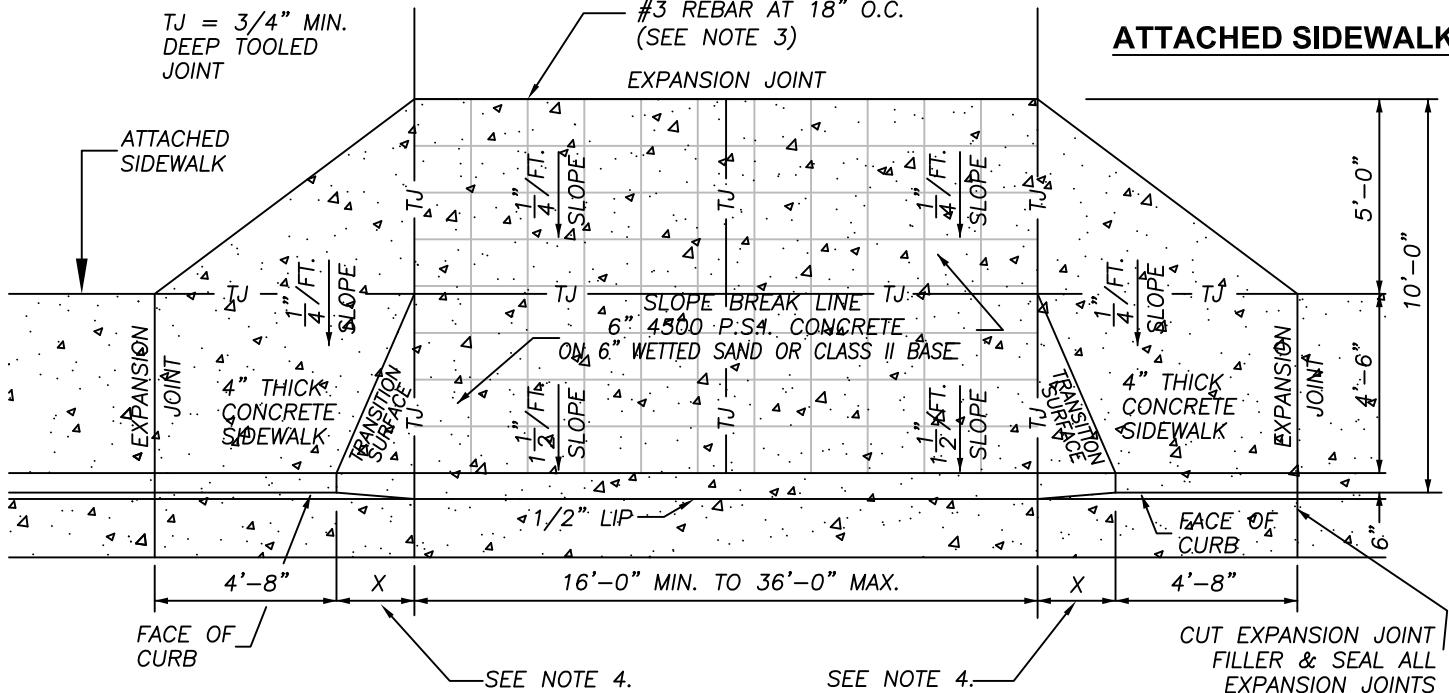

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(760) 344-5800



APPROVED BY CITY ENGINEER:

STANDARD DETAILS

SCALE: NTS

COMMERCIAL DRIVEWAY DETAIL

G-2


BRAWLEY, CALIFORNIA

DATE:	BY:
10/5/04	A.C.

OWNER: CITY OF BRAWLEY


**TJ = 3/4" MIN.
DEEP TOOLED
JOINT**

DETACHED SIDEWALK

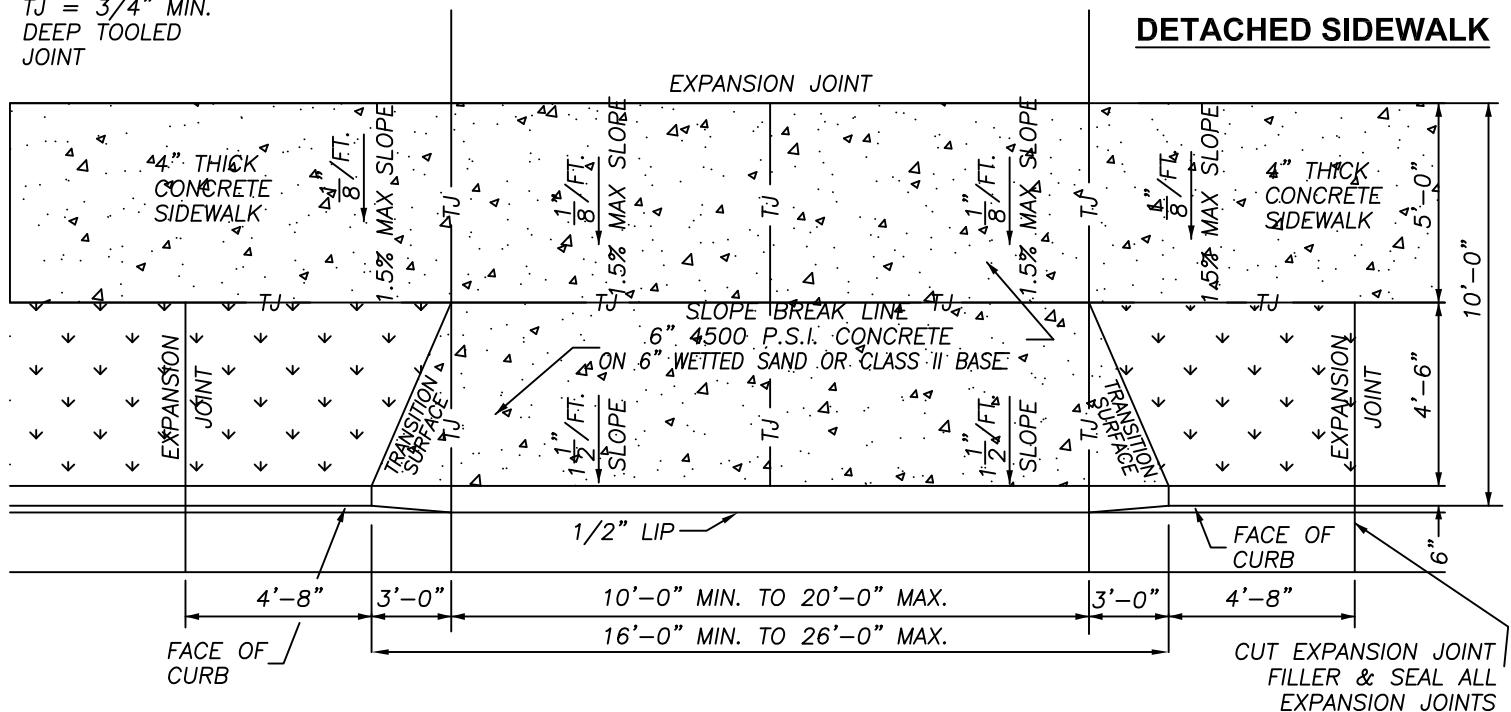

TJ = 3/4" MIN.
DEEP TOOLED
JOINT

ATTACHED SIDEWALK

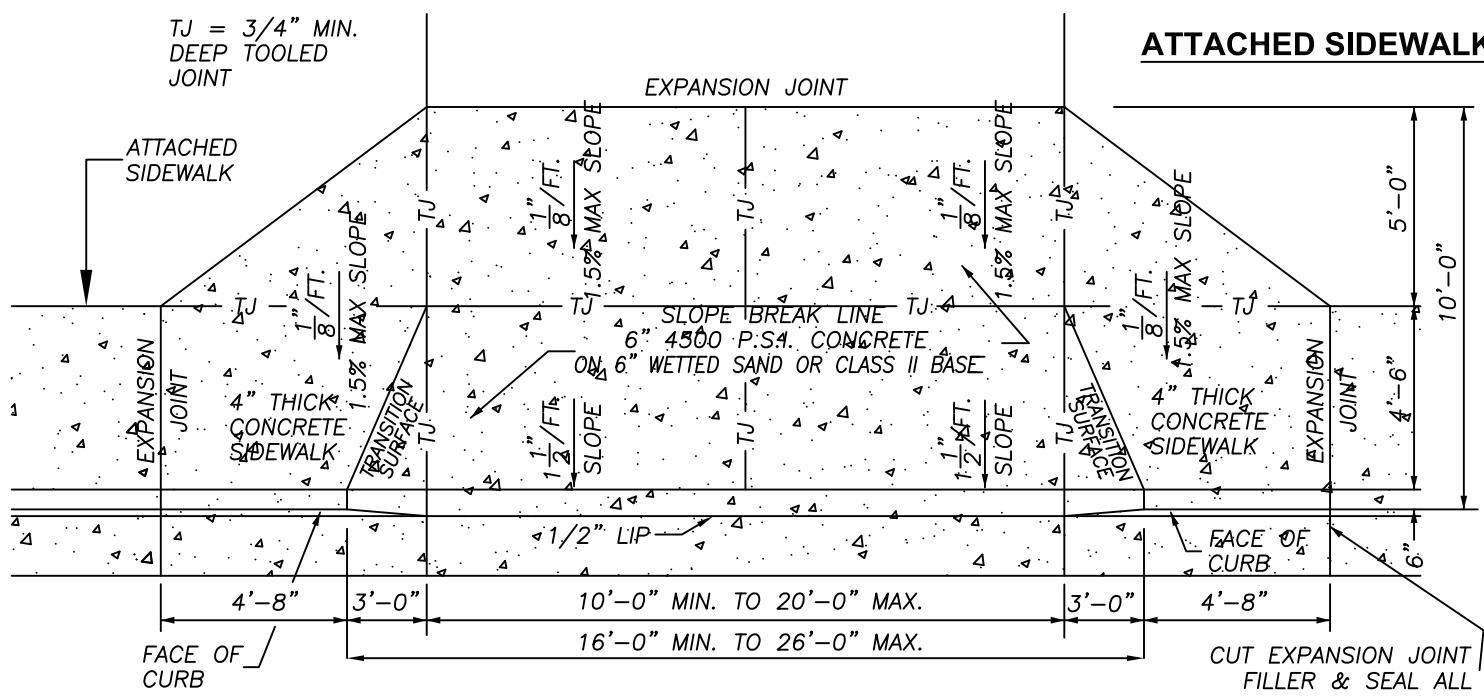

NOTE:

- NOTE:
1. A MINIMUM OF 24 HOURS PRIOR NOTICE TO SCHEDULE AN INSPECTION BY THE CITY OF BRAWLEY PUBLIC WORKS DEPARTMENT IS REQUIRED.
2. THIS DETAIL IS ACCURATE AND COMPATABLE WITH AREAS THAT HAVE AN ADJACENT ATTACHED SIDEWALK.
3. $\frac{1}{6}$ " PER FOOT / 1.5% MAX SLOPE FOR SIDEWALK AREA.



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STANDARD DETAILS


SCALE: NTS

RESIDENTIAL DRIVEWAY DETAIL

BRAWLEY, CALIFORNIA



DATE:	BY:
10/7/04	A.C.

G-3

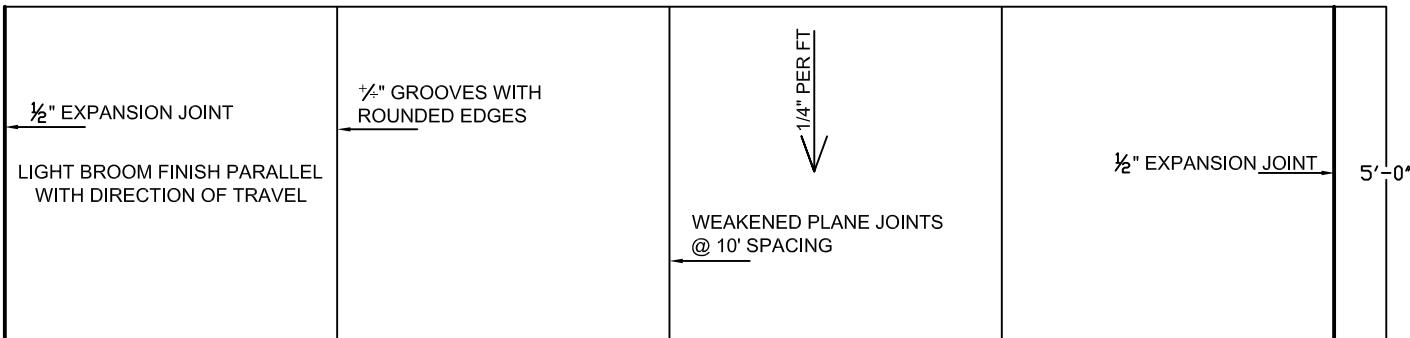


NOTE:

1. $\frac{1}{2}$ " EXPANSION JOINT @ EACH END OF CURB RETURN AND @ 40'-0" INTERVALS.
2. STANDARD WEAKENED PLANE JOINTS @ 10'-0" INTERVALS.
3. USE CLASS "B" P.C.C.
4. NO TRANSVERSE EXPANSION JOINTS WITHIN LIMITS OF DRIVEWAY.
5. MAY BE POURED AS A MONOLITHIC.
6. P.C.C. FOR THIS WORK SHALL MEET OR EXCEED 4,000 PSI COMPRESSIVE STRENGTH AT 28 DAYS.
7. $\frac{1}{4}$ " PER FT. SLOPE FOR DRAINAGE.
8. ALL EXPANSION JOINTS ARE REQUIRED TO BE CUT DOWN AND CAULKED. AS PER GREENBOOK SECTION 201-3.4.
9. GRADE TO DRAIN TOWARDS STREET.

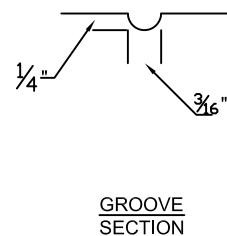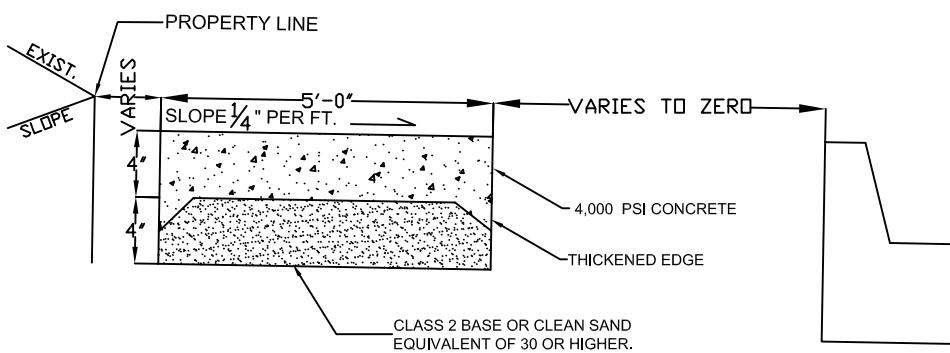

GROOVE SECTION

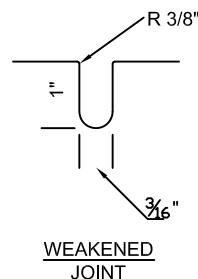

WEAKENED JOINT

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APPROVED BY CITY ENGINEER:

STANDARD DETAILS

SCALE:
NTS



SIDEWALK DETAIL

G-4

BRAWLEY, CALIFORNIA

DATE: 11/4/04 BY: A.C.
JOB NO.

OWNER: CITY OF BRAWLEY

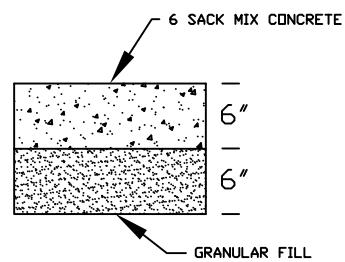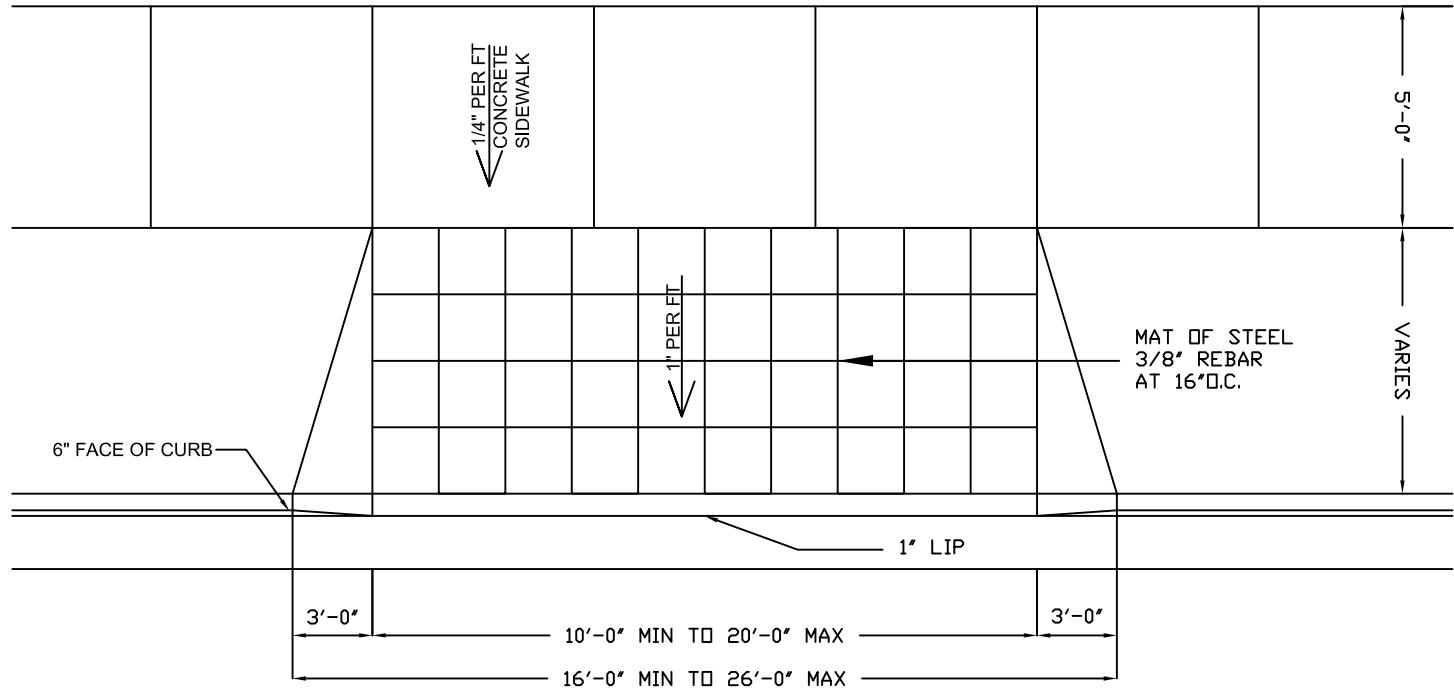

ALLEY
APPROACH
CROSS SECTION
NTS



CITY OF BRAWLEY
ENGINEERING DEPT.
180 S. WESTERN AVE.
BRAWLEY, CA 92227
(760) 344-5800

STANDARD DETAILS

SCALE:

NTS

ALLEY APPROACH


G-6

BRAWLEY, CALIFORNIA	DATE 7/11/02
OWNER CITY OF BRAWLEY	BY A.C.

JOB
No.



HIGH PRESSURE SODIUM VAPOR
LUMINAIRE COMPLETE WITH PHOTO
ELECTRIC CELL, 150 W.; EXCEPT,
WHERE OTHERWISE INDICATED.

75 W.	NEIGHBORHOOD
100W.	CUL-DE-SAC'S
150W.	INTERSECTIONS

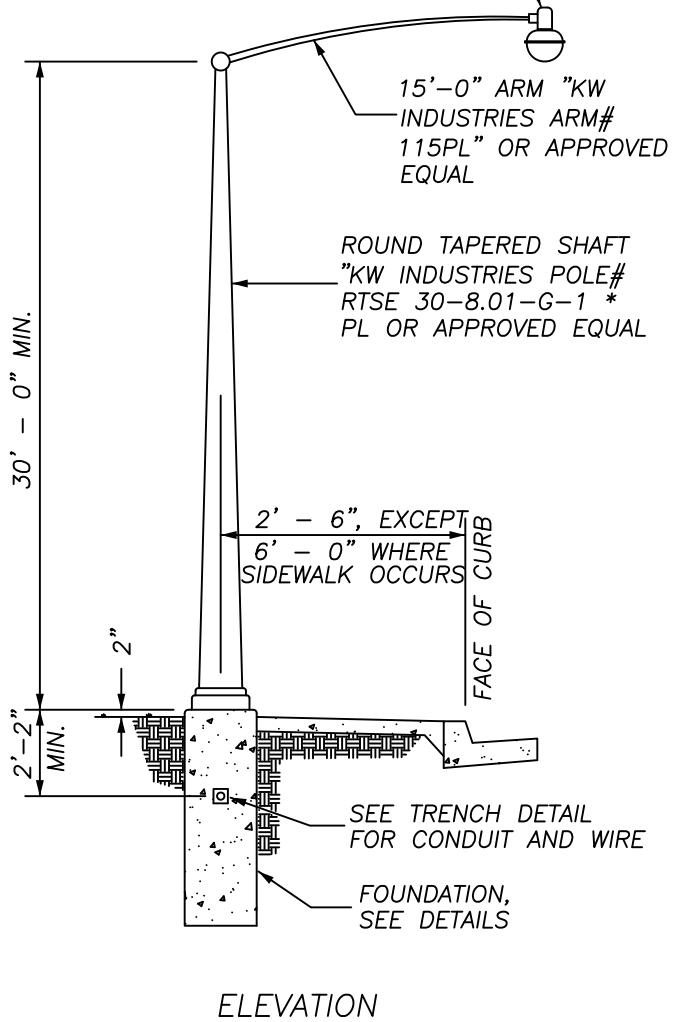

NOTE:

1. 150 WATT LUMINAIRE AT INTERSECTIONS OR IN FRONT OF INTERSECTIONS AND 75 WATT ELSEWHERE.
2. NO. 4 TIES TO BE 12" SEPARATION FROM TOP AND BOTTOM.
3. SIDEWALL REBAR TO BE 3" MIN FROM EXCAVATION WALLS AND BOTTOM.

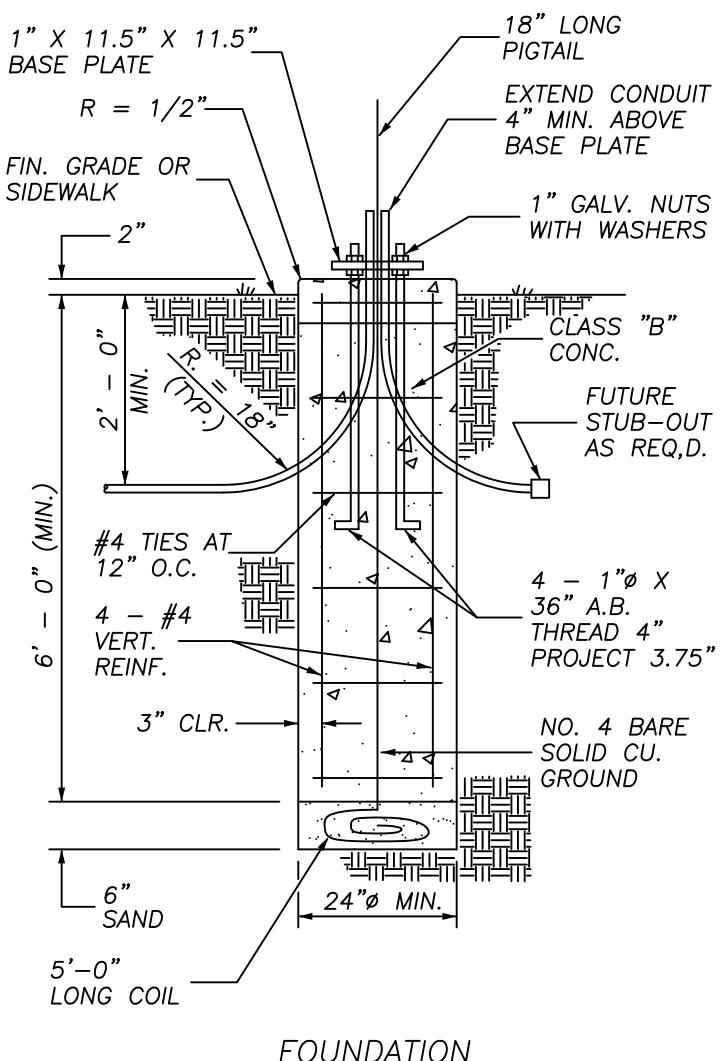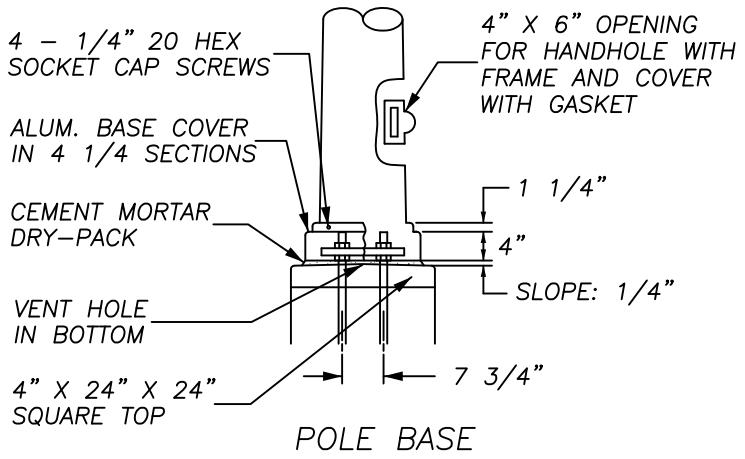

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APPROVED BY CITY ENGINEER:

STANDARD DETAILS

SCALE:
NTS


STREET LIGHT DETAIL

H-1

BRAWLEY, CALIFORNIA

DATE: 10/5/04 BY: A.C.
JOB NO.

OWNER: CITY OF BRAWLEY

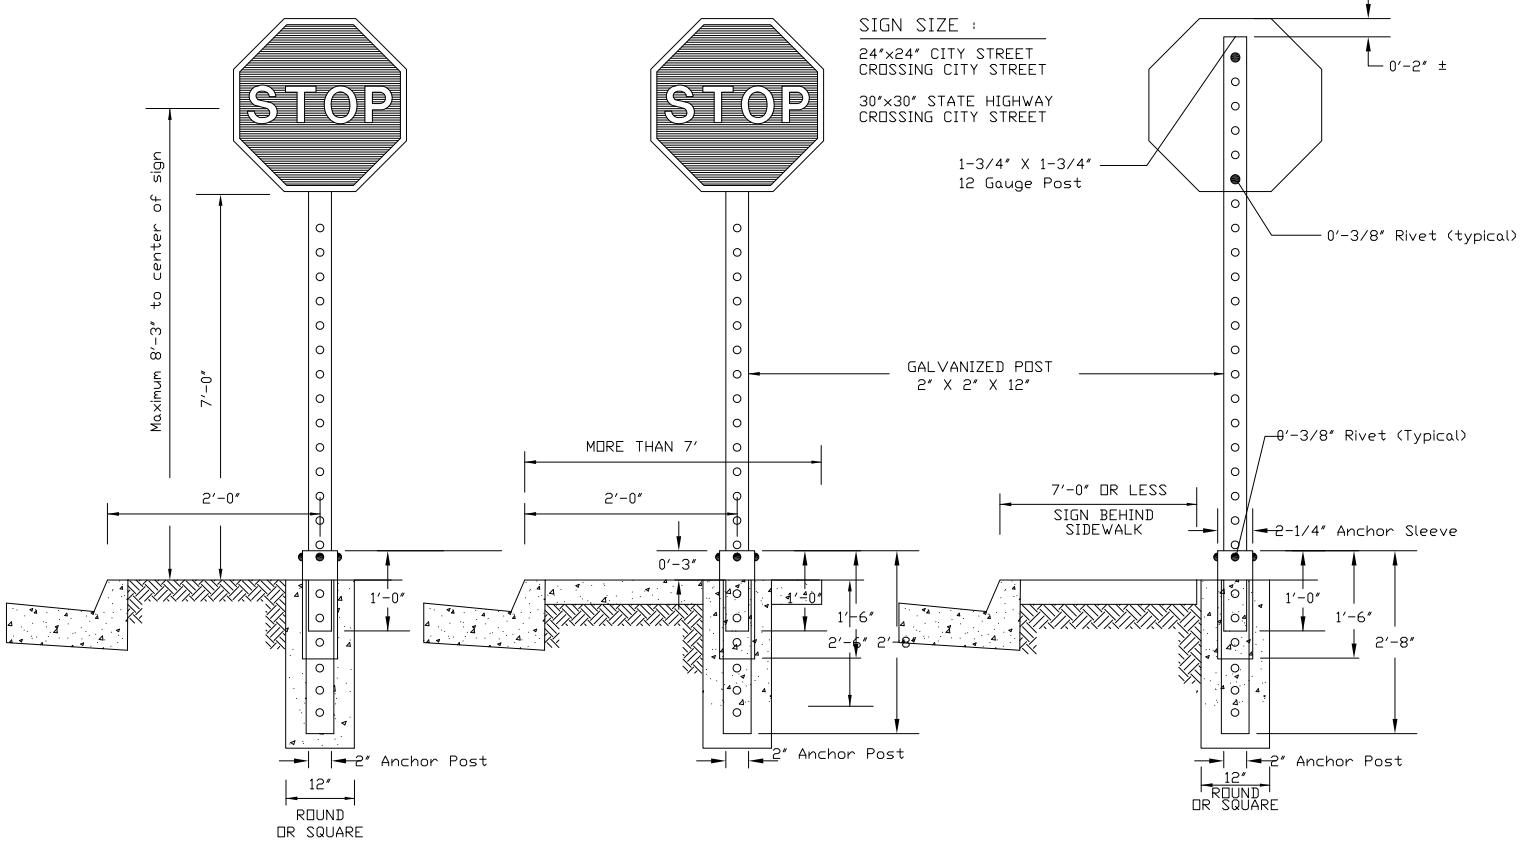

NOTES:

- STRUCTURAL STEEL TUBING USED FOR POST & SLEEVES SHALL BE GALVANIZED 12 GAUGE COLD ROLLED STEEL, OF THE NOMINAL DIMENSIONS SHOWN HEREON AND MEET THE REQUIREMENTS OF ASTM A446.
- GALVANIZING SHALL BE PER ASTM A525. POSTS & SLEEVES SHALL HAVE 7/16" DIA. HOLES SPACED 1" O.C. $\pm 1/8"$ & SHALL HAVE NO MORE VARIATION IN STRAIGHTNESS THAN 1/16" IN. 3'. POSTS SHALL BE SQUARE WITHIN $\pm 0.014"$, HAVE TWIST NO GREATER THAN 0.062" IN 3' AND HAVE CORNER RADII OF 5/32" $\pm 1/64"$.
- THE SIGN SHALL BE MOUNTED ON POST IN ACCORDANCE WITH SECTION 56, "SIGN" OF THE STATE STANDARD SPECIFICATIONS. ALL FASTENING HARDWARE IS TO BE PROVIDED BY THE CONTRACTOR.
- MAXIMUM SIGN SIZE 5.2 SQ. FT.



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SCALE:
NTS


TRAFFIC REGULATORY SIGNING

H-7

BRAWLEY, CALIFORNIA

DATE: 5/12/05 BY: A.C.
JOB NO.

OWNER: CITY OF BRAWLEY

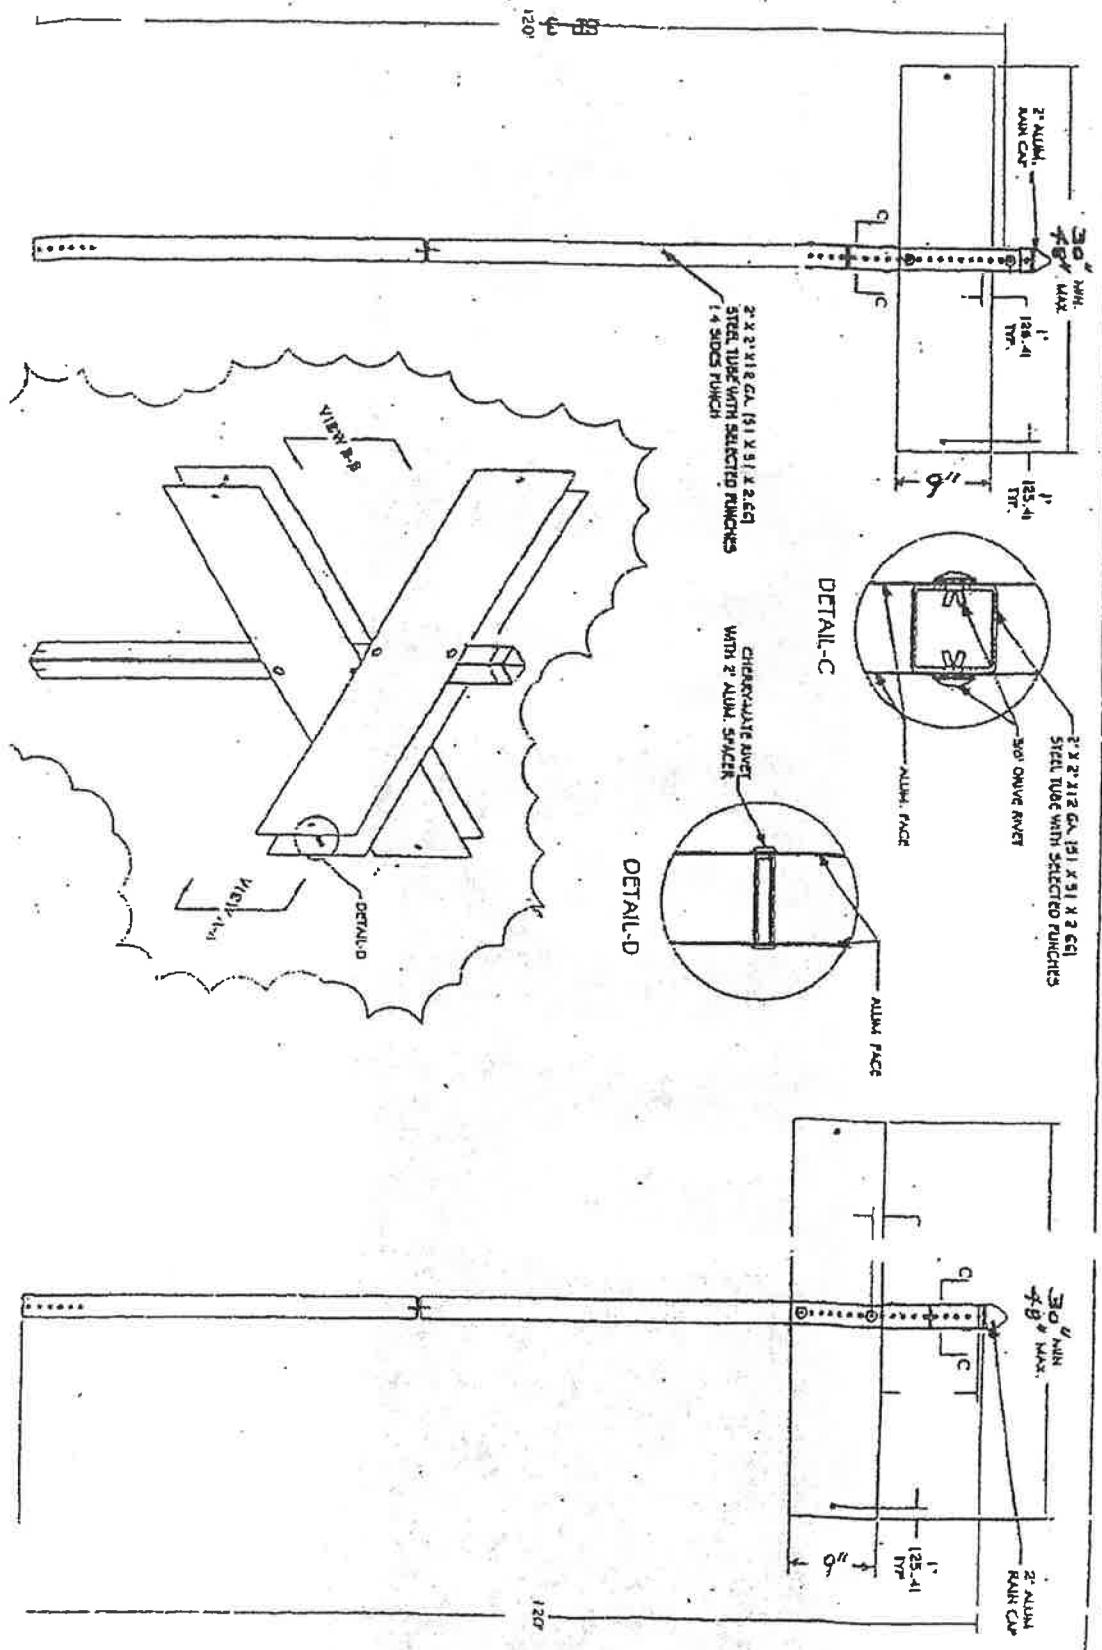


H-8



BRAWLEY
Home of the Cattle Call


WILD
WIND
ST
400

H-9

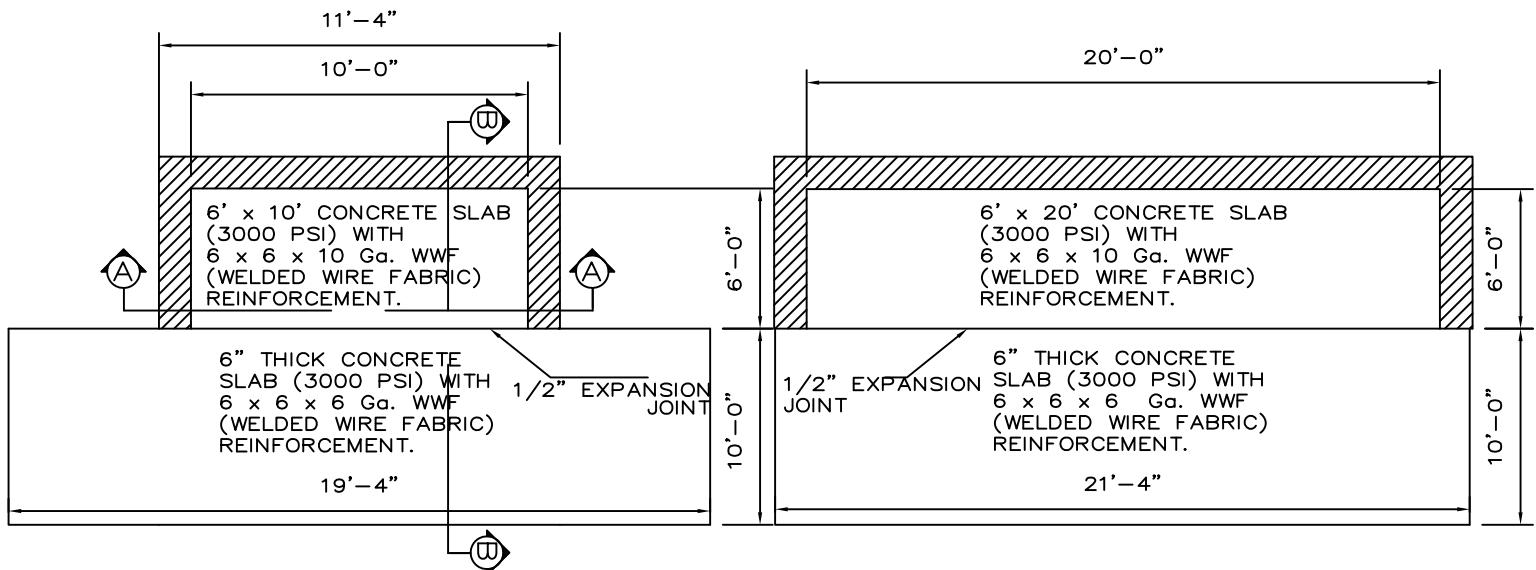

SINGLE
DUMPSTER ENCLOSURE
NTS

DOUBLE
DUMPSTER ENCLOSURE
NTS

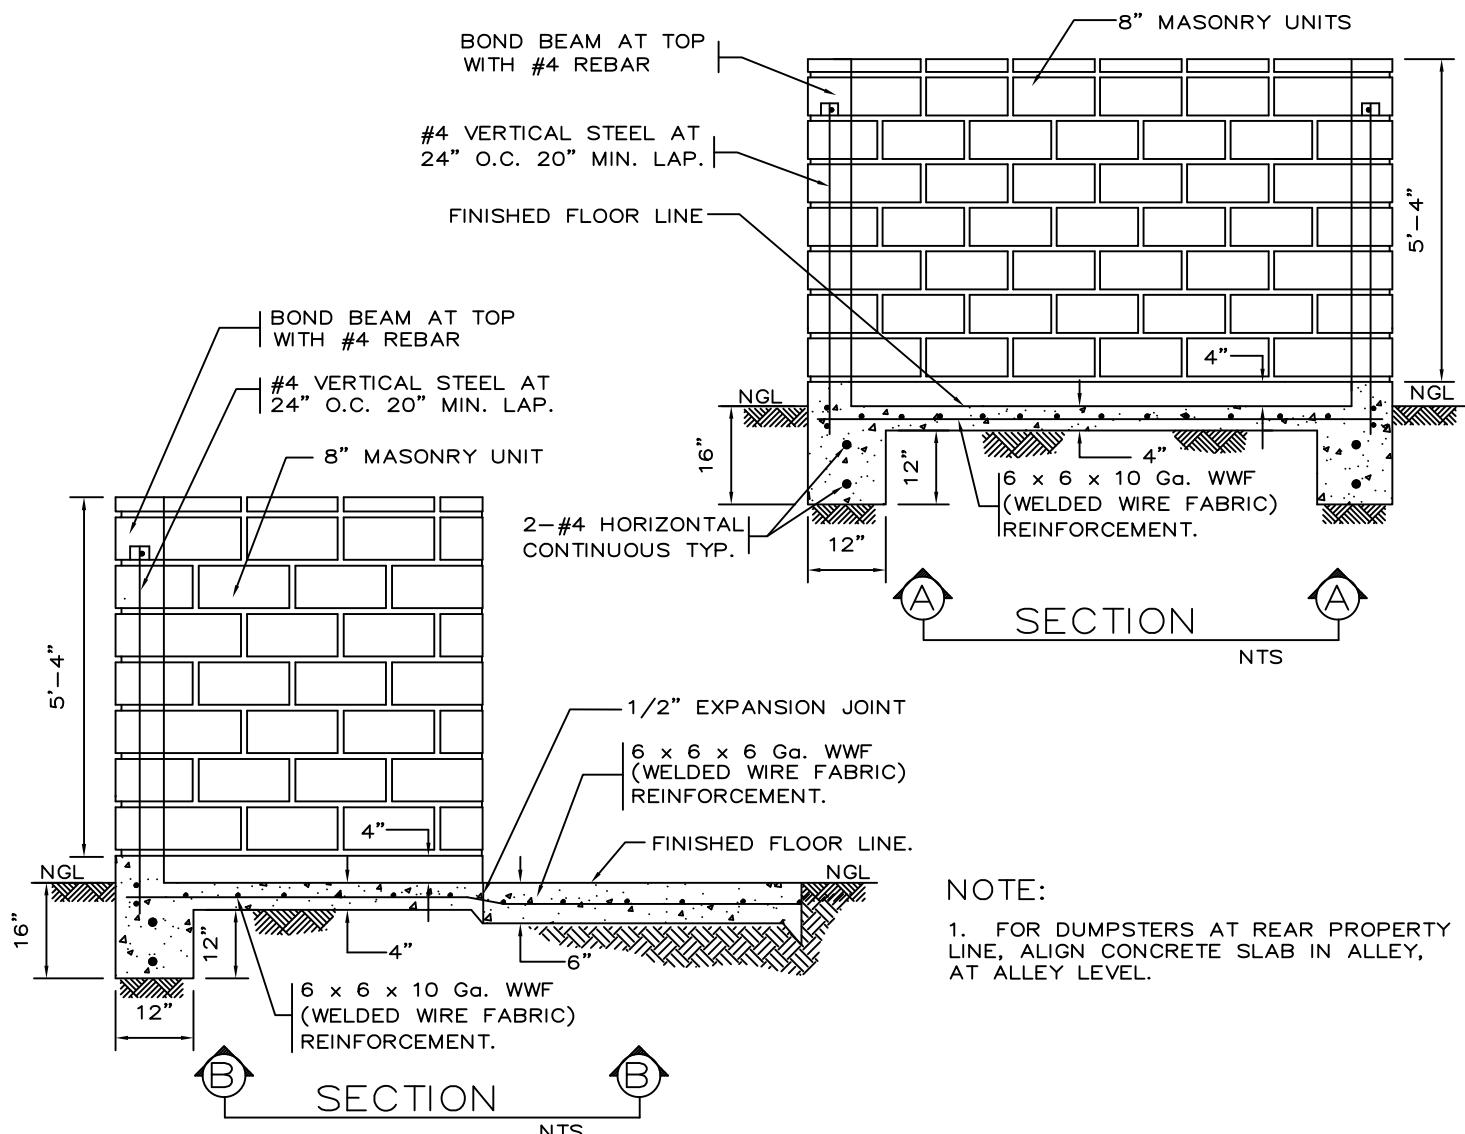

NOTE:

1. FOR DUMPSTERS AT REAR PROPERTY LINE, ALIGN CONCRETE SLAB IN ALLEY, AT ALLEY LEVEL.

DUMPSTER ENCLOSURE

City of Brawley

STANDARD DETAIL

APPROVED CITY ENGINEER

DRAWN BY	AC	CHK'D BY	YAT	REVISED BY	
DATE	10/08/02	DATE	10/08/02	DATE	